

UNIVERSITY OF SRI JAYEWARDENEPURA FACULTY OF MANAGEMENT STUDIES AND COMMERCE

BIDDING DOCUMENT

CONSTRUCTION OF PROPOSED INTERIOR WORKS FOR THE POSTGRADUATE CENTRE FOR BUSINESS STUDIES OF THE FAULTY OF MANAGEMENT STUDIES AND COMMERCE OF THE UNIVERSITY OF SRIJAYEWARDENEPURA

IFB NUMBER 09W/2025/FMSC

EMPLOYER:

Vice Chancellor, University of Sri Jayewardenepura Gangodawila, Nugegoda.

October 2025

Notes

- 1. The work involved in the contract covers the construction and completion of the works described and the maintenance of the said works from the date of handing over to the Vice Chancellor University of Sri Jayewardenepura
- 2. Standard Bidding Document (SBD) for this contract is "Standard Bidding Document Procurement of works Minor Contracts (CIDA/SBD/03), published by CIDA
- 3. This document consists only volume 2 and bidders are advised to refer SBD 03 CIDA document for volume 1

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Invitation for Bids (IFB)

UNIVERSITY OF SRI JAYEWARDENEPURA

CONSTRUCTION OF PROPOSED INTERIOR WORKS FOR THE POSTGRADUATE CENTRE FOR BUSINESS STUDIES OF THE FACULTY OF MANAGEMENT STUDIES COMMERCE, UNIVERSITY OF SRI JAYEWARDENEPURA

IFB No: 09W/2025/FMSC

- 1. The Chairman, Department Procurement Committee, on behalf of the University of Sri Jayewardenepura, invites sealed bids from eligible and qualified bidders for the Construction of Proposed Interior Works for the Postgraduate Centre for Business Studies of the Faculty of Management Studies and Commerce of the University of Sri Jayewardenepura, as described below. The estimated of the project is Rs.15 Mn. (Including VAT).
 - The work consists of Interior work as indicated in the BOQ. The construction period is **75 Days**.
- 2. Bidding will be conducted through the National Competitive Bidding Procedure.
- 3. To eligible for contract award, the successful bidder shall not have been blacklisted and shall meet following requirements.

CIDA Registration Require:

Specialty: Building Construction

Grade: C7 or above

- 4. Qualification requirements to qualify for contract award include:
 - i. Average turnover of the projects performed in last three years shall be at least Rs.15 Million in similar nature (construction of Interior Works).
 - ii. The minimum amount of liquid assets and/or credit facilities net of other contractual commitments and exclusive of any advance payments which may be made under the contract shall be not less than Rupees 6 Million (Documentary evidence should be attached)
- 5. Interested bidders may obtain further information from Senior Assistant Bursar (Supplies), Faculty of Management Studies and Commerce, University of Sri Jayewardenepura, Gangodawila, Nugegoda Telephone 0112 803 343, Fax 0112 803653 and inspect the Bidding Documents on working hours from 24.11.2025 to 15.12.2025 at the address given below.

6. A complete set of Bidding Documents in English language may be purchased by interested

bidders on the submission of a written application to the Senior Assistant Bursar (Supplies),

Faculty of Management Studies and Commerce, University of Sri Jayewardenepura from

24.11.2025 to 15.12.2025 from 9.00hrs to 12.00hrs and 1.00hrs to 14.30hrs upon payment of a

non-refundable fee Rs. 3,500.00 The method of payment will be by cash payment to the Shroff

of the University.

7. Bids shall be delivered in duplicate to the address given below on or before13.30 hrs on

16.12.2025. Late bids will be rejected. Bids will be opened soon after closing in the presence of

the bidder's representatives who choose to attend.

8. Sealed Bids shall be delivered in duplicate to the address of the Senior Assistant Bursar

(Supplies), Faculty of Management Studies and Commerce, University of Sri

Jayewardenepura, Gangodawila, Nugegoda on or before 13.30hrs on 16.12.2025. late

bids will be rejected. The Technical Proposal of bids will be opened soon after the closing

of bids at the Board room of Faculty of Management Studies and Commerce in the

presence of the bidder's representatives who choose to attend.

9. Bids shall be valid up to 02.03.2026 (77 days)

10. Each bid shall be accompanied by Bid Security of Rupees. 150,000.00, irrevocable,

unconditional on demand Bank Guarantee obtained from a bank operating in Sri Lanka

and approved by the Central Bank of Sri Lanka, and addressed to the Vice Chancellor,

University of Sri Jayewardenepura, using the form included in Section V, Standard

Forms. Bid Security shall be valid up to 30.03.2026 (105 days)

11. This Procurement Using the measure-and-pay method.

12. The pre-bid meeting will be held at 11.00 a.m. on 02.12.2025 at the Board Room of the

Faculty of Management Studies and Commerce, University of Sri Jayewardenepura.

Participation of the Bidders or their authorized representatives at the pre-bid meeting is

mandatory.

The address for inspection of bidding Documents, Purchasing of Bidding Documents and

Submission of Bids is as follows.

Senior Assistant Bursar (Supplies),

Faculty of Management Studies and Commerce

University of Sri Jayewardenepura,

Gangodawila,

Nugegoda.

Telephone: 0112 803 343

Email: sufmsc@sjp.ac.lk

Section - 4

FORM OF BID AND QUALIFICATION INFORMATION

FORM OF BID

Name of Contract:		Construction of Proposed Interior Works for the Postgraduate Centre for Business Studies of the Faculty of Management Studies and Commerce, University of Sri Jayewardenepura
То	:	Vice Chancellor, University of Sri Jayewardenepura
Ge	entlemen,	
1.	procurement of Schedule, Spec the above-name and remedy as Schedule, Spec Lankan Rupees	the Conditions of Contract given in the Standard Bidding Document-F Works-Minor Contracts [(ICTAD/ SBD/ 03- First edition, January 2007], ifications, Drawings and Bills of Quantities and addenda for the execution of ed Works, We/I the undersigned, offer to execute and complete such Works my defect therein conformity with the aforesaid Conditions of Contract, effications, Drawings, Bill of Quantities and Addenda for the sum of Sries. (LKR) Impact of the Conditions of Contract, effications, Drawings, Bill of Quantities and Addenda for the sum of Sries
2.	We/I acknowle	dge that the Schedule forms part of our Bid.
3.	We/I undertak	e, if our Bid is accepted, to commence the Works as stipulated in the
	Schedule, and t	o complete the whole of the Works comprised in the Contract within the time
	stated in the Sc	hedule.
4.	We/I agree to a	bide by this Bid for the period stated in the Sub-Clause 15 of Instructions to
	Bidder so any	extended period and it shall remain binding upon us and may be accepted at
	any time before	e the expiration of that period.
5.		il a formal Agreement is prepared and executed this Bid, together with your nce thereof, shall constitute a binding contract between us/ me.
6.	We/I understan	d that you are not bound to accept the lowest or any bid you may receive.
	Dated this	day of
	authorized to si	gn tenders for and on behalf of
		(IN BLOCK CAPITALS)
	Signature	:
	Company S	
	Address	:
	Witness	:

QUALIFICATION INFORMATION

(to be completed by the bidder and submitted with the Bid)

Eligibility Requirement		Bidde	er's Qualification	
CIDA Registration				
Registration number				
Grade	C7 or Above			
Specialty	Building Construction			
Date of Expiry				
Blacklisted Contractors				
Have you been declared as a defaulted contractor l or any other Agency		PA		Yes/No
If yes provide detai	ils			
VAT Registration Number	If not registered, should submit a leftrom the Commissioner General of Inland Revenue certifying that the bidder has exempted for collection VAT	•		
Construction Programme	(attach as annex)			
Legal Status	Public/Private Company/Partnership/	Sole p	proprietor	
	Eligibility Requireme	nt		Bidder's Qualification
Qualification and experience of key staff	Category, Experience and Qualifications	Required Nos.		Proposed by bidder (Name, experience and qualifications)
	(a) Interior Designer			
	Interior Designing, having at least 03 years' experience in interior works in interior design and construction.		1	

	Technical Officer Should be Technical Officers we qualification of National Certificate Technology or equivalent having least 5 years' post-qualify experience in projects of similar nat and shall be based at the site as a when necessary.	at ing ure		1		
	Eligibility Requirement		B	idder's (Qualif	ication
Average annual value of construction work performed in last three years	Submit details of turnover of construction work during last three years with supporting documents	•	Year	Annual Value of Construction Work (Turnover) (Rs.)		
Experience in similar work	Submit details of similar nature (design and construction of interior projects) and size at least Rs. 15 million without VAT in one contract within last three years		Year	Contr. Value (Description of Work and Client

Signature of the Bidder:	

Section - 5

SCHEDULE

Note:

This section shall be read in conjunction with Section 1 - Instructions to Bidders and Section 3 - Conditions of Contract, and is intended to provide specific information in relation to corresponding Clauses in Section 1 & 3. Whenever there is an ambiguity, the provisions in Section 5 - Schedule shall supersede these provided in Section 1 - Instructions to Bidders and Section 3 - Conditions of Contract.

Schedule

ITB Clause	Conditions of Contract Clause	Item	Data
1	1.1.8	Employer is:	Name: The Vice Chancellor
			Address: University of Sri Jayewardenepura, Gangodawila, Nugegoda
	1.1.10	Engineer is:	Name: Project Manager
			Address : Capital Woks and Planning, University of Sri Jayewardenepura, Gangodawila, Nugegoda
1&13	1.1.21	Summary of Works	The works consists of Construction of Proposed Interior Works for the Postgraduate Centre for Business Studies of the Faculty of Management Studies and Commerce of the University of Sri Jayewardenepura as indicated in the BOQ.
			Located at: New Building Stage V.
			Contract Name: Construction of Proposed Interior Works for the Postgraduate Centre for Business Studies of the Faculty of Management Studies and Commerce of the University of Sri Jayewardenepura
			Contract Number: 09W/2025/FMSC
1	1.1.14	Intended Completion Date	Intended Completion Date is 75 days from the Start Date
2		Source of funds	The source of funds is Faculty Development Funds, Faculty of Management Studies and Commerce, University of Sri Jayewardenepura.
3		Eligibility	The requirement is;
			CIDA Registration
			Specialty: Building Construction
			Grade: C7 or above
12		Documents of the Bid	Not applicable
13	10.10	Price Adjustment	The Contract is not subject to price adjustment in accordance with Sub-Clause 10.10 under option B of the Conditions of Contract.
16		Bid Security / Bid	Bid shall be include a Bid Security:

ITB Clause	Conditions of	Item	Data				
	Contract Clause						
		Security Declaration	• For an amount of Rupees 150,000.00 .				
		Decial attori	• bank guarantee issued by a commercial bank operating in Sri Lanka approved by the central bank of Sri Lanka. Using the form for bid security (unconditional guarantee) included in Section 9, Standard Forms.				
			• Remain valid till 30.03.2026.				
31	4.4	Performance Security	Amount of Performance Security required is 05 % of the Initial Contract Price.				
			The form acceptable is unconditional Guarantee issued by a commercial bank operating in Sri Lanka approved by the central bank of Sri Lanka. Using the form for bid security (unconditional guarantee) included in Section 9, Standard Forms.				
	6.4	Late Completion	The amount to be paid is 0.05 % of the Initial Contract Price per Day, subjected to maximum of 10 % of Initial Contract Price.				
	8.1	Notification of defects	The period for defect Notification is 365 Days from Taking Over.				
	10.3	Retention	The amount of retention is 10% of certified work done.				
			The maximum limit of 5% of Initial Contract Price.				
	10.12	Advance Payment	The form acceptable is unconditional guarantee issued by Central Bank approved commercial bank operating in Sri Lanka. Upon the payment of the advance payment in full the Employer shall return the original of the guarantee to the Contractor.				
	13.1 (c)	Insurance. Third party	Minimum amount for third party insurance is Rupees 16,500,000.00.				
33	1.1.11	Adjudicator	Fees and types of reimbursable expenses to be paid to the Adjudicator shall be on a case to case basis				
	14.0	Resolution of Disputes	and shall be shared by the Contractor and the Employer.				

Section - 6 SPECIFICATIONS

SPECIFICATIONS

- 1. All materials and constructions should conform to relevant standards specified in documents of ICTAD unless specified otherwise in the Contract Documents.
- 2. Use of all materials and constructions are subject to the satisfaction of the Engineer or Architect.
- 3. The works under the contract agreement shall be executed in accordance with the specifications given in the following publications issued by the Institute for Construction Training and Development (ICTAD), No. 123, Sawsiripaya, Wijerama Mawatha, Colombo 07 and as specified.

Work	Publication Number
Building Works (Vol. I)	SCA/4
Building Works (Vol. I)	SCA/4/II
Specifications for Electrical & Mechanical Works - [2nd Edition (Revised) – August 2000]	SCA/8

Section - 7 BILLS OF QUANTITIES

	Item	Description	Unit	Qty	Rate (Rs)	Amount (Rs)
A	Block - A					
A 01	Full height solid partition	Supplying and installation of 9mm thk. Gypsum solid double partitions including framework and apply two coats of relevant color (mustered yellow/ white) paint finishes to surface over one coat of acrylic filler. Method: Installation of Aluminium Framework Fix the 50mm x 25mm U-Track on the floor and ceiling using appropriate wall plugs and screws at equal centers. Insert 50mm x 50mm C-Studs vertically at equal centers within the U-Track. Ensure the framework is properly aligned and leveled. Gypsum Board Installation Measure, cut, and position 9mm gypsum boards to fit the framework. Ensure boards flush with the column level. Secure the boards using drywall screws (every 300mm along the studs). Keep a 3mm gap between boards for joint filling. Apply jointing tape over board joints. Use acrylic filler to cover joints, screw holes, and imperfections. Allow the filler to dry completely before sanding. Smooth rough surfaces of and apply one coat of acrylic filler and two coats of relevant colour paint	sqm	10		
02	Full height glass partition	as top coat. Supplying and installation of 12mm thk. Tempered glass partition work with black powder coated "U" channel profile Aluminium framework and complete with neat finished. Method: Installation of Aluminium U-Channel Cut U-channel profiles to required lengths based on drawing.	sqm	33		

	 Fix aluminium U-channel to floor, ceiling, and side walls using countersunk screws and wall plugs at intervals of 300–400mm. Use a laser or spirit level to ensure alignment. Insert rubber gaskets inside the channel to cushion the glass. Carefully lift and insert 6mm tempered glass panels into the U-channel. Ensure even spacing and plumb alignment of glass panels. Use additional rubber gaskets or spacers to fix the glass securely and prevent rattling. Apply clear silicone sealant along the junctions (edges of glass and profile and between 2 glasses) to ensure stability and an aesthetic finish. Clean the glass surface and profile to remove dust, fingerprints, and sealant smudges. Conduct final inspection for level, alignment, and finish quality. Specification of Glass: Type: Clear tempered glass Thickness: 12mm 			
	 Edge Finish: Polished edges Height: As per approved drawings Specification of Aluminium Profile: Type: "U" Channel Profile Material: Aluminium alloy (6063 T5) Finish: Black powder-coated Matt finished Size: Internal width: 8mm (to accommodate glass + gasket) Depth (height of leg): 25–30mm Thickness of profile: 1.5–2mm (minimum) Accessories: Rubber gaskets, corner joints, screws, wall plugs Specification of Sealant: Silicone clear sealant, non-acidic, anti-fungal 			
03 Partial height (2700mm)	Supplying and installation of 9mm thk. Gypsum solid double partitions including framework and apply two	sqm	36	

	solid	coats of relevant color (blue) paint				
	partition	finishes to surface over one coat of				
	Partition	acrylic filler.				
		Method:				
		Installation of Aluminium Framework				
		• Fix the 50mm x 25mm U-Track on				
		the floor and ceiling using				
		appropriate wall plugs and screws				
		at equal centers.				
		Insert 50mm x 50mm C-Studs				
		vertically at equal centers within				
		the U-Track.				
		 Ensure the framework is properly 				
		aligned and leveled.				
		anglied and leveled.				
		Gypsum Board Installation				
		Measure, cut, and position 9mm				
		gypsum boards to fit the				
		framework.				
		Ensure boards flush with the				
		column level.				
		 Secure the boards using drywall 				
		screws (every 300mm along the				
		studs).				
		1				
		Keep a 3mm gap between boards for joint filling				
		for joint filling.				
		Apply jointing tape over board icints				
		joints.				
		Use acrylic filler to cover joints, agray holes, and imporfactions.				
		screw holes, and imperfections.				
		Allow the filler to dry completely hefore conding				
		before sanding.				
		Smooth rough surfaces of and				
		apply one coat of acrylic filler and				
		two coats of relevant colour paint				
0.4	D	as top coat		20		
04	Partial haight	Supplying and installation of 12mm	sqm	29		
	height	thk. Tempered glass partition work with black powder coated "U" channel				
	(2700mm)	profile Aluminium framework and				
	glass partition	complete with neat finished.				
	paruuon	complete with heat finished.				
		Method:				
		wichiou.				
		Installation of Aluminium U-Channel				
		• Cut U-channel profiles to required				
		lengths based on drawing.				
		• Fix aluminium U-channel to floor,				
		ceiling, and side walls using				
		countersunk screws and wall plugs				
		at intervals of 300–400mm.				
		Use a laser or spirit level to ensure				
		alignment.				
	i	,			1	

				1	
		 Insert rubber gaskets inside the channel to cushion the glass. 			
		Installation of GlassCarefully lift and insert 6mm			
		tempered glass panels into the U-			
		channel.			
		 Ensure even spacing and plumb 			
		alignment of glass panels.			
		Use additional rubber gaskets or spacers to fix the glass securely			
		and prevent rattling.			
		Apply clear silicone sealant along			
		the junctions (edges of glass and			
		profile and between 2 glasses) to			
		ensure stability and an aesthetic finish.			
		Clean the glass surface and profile			
		to remove dust, fingerprints, and			
		sealant smudges.			
		 Conduct final inspection for level, alignment, and finish quality. 			
		ungiment, and missi quarty.			
		Specification of Glass:			
		Type: Clear tempered glassThickness: 6mm			
		 Edge Finish: Polished edges 			
		Height: As per approved drawings			
		Specification of Aluminium Profile:			
		• Type: "U" Channel Profile			
		Material: Aluminium alloy (6063 T5)			
		Finish: Black powder-coated Matt			
		finished			
		Size:Internal width: 8mm (to			
		accommodate glass + gasket)			
		- Depth (height of leg): 25–30mm			
		- Thickness of profile: 1.5–2mm			
		(minimum)Accessories: Rubber gaskets,			
		corner joints, screws, wall plugs			
		Specification of Sealant:Silicone clear sealant, non-acidic,			
		anti-fungal			
05	D1 – Glass	Supply and fixing of size 900mm x	Nr	05	
	door	2100mm 12mm thk. Tempered glass			
		door and complete and finished with necessary door fittings and accessories			
		and complete.			
		Mothoda			
		Method:			
		• Verify the door size (900 x			

		 2100mm) and inspect the glass for damage. Ensure factory-prepared holes/cutouts for fittings are present and accurate. Attach top and bottom patch fittings to the glass door using rubber gaskets. Fix door handles with proper alignment using pre-drilled holes. Install locking system and align the strike plate location on the adjacent partition or floor. Lift the glass door panel and position it between the pivot points (top and bottom). Check for smooth swinging operation and correct alignment. 			
06	Carpeting (Gray color Carpet)	operation and correct alignment.	sqm	65	
		Color: Approved gray colour Pile Weight: Minimum 20oz Carpet Thickness: 5mm Padding: Single-padded Subfloor: Existing cut and polished			

		cement floor surface			
07	Vinyl flooring	Supplying and laying of 3mm thk. approved vinyl flooring design, all joints in neat finished. Complete and finish as per the design. (Prime cost: Rs. 600 per sq.ft) Method: Inspect the subfloor to ensure it is clean, smooth, dry, and level. Remove any debris, old adhesives, paint, or contaminants. Apply self-leveling compound if necessary to correct floor	sqm	53	
		 unevenness. Moisture content of subfloor should be below 3%. Apply adhesive evenly using a notched trowel to the subfloor in sections. Allow the adhesive to tack-up as per manufacturer's recommendations (open time). Carefully lay the vinyl into the adhesive. Press and smooth the vinyl to remove air pockets. Use a 50–75 kg floor roller to bond the flooring evenly and eliminate bubbles. Maintain tight, consistent joints between sheets for a seamless finish. 			
08	Gypsum concealed type Ceiling	Supply and installation of 9mm thick plain Gypsum ceiling with 50mm x 25mm GI box frame work complete with two coats of emulsion painting (blue/ white) finishes to surface over one coat of acrylic filler. Rate shall include for hanging of ceiling with thread bars in order. Method: Installation of Framework Fix perimeter channels on walls at the marked ceiling level using appropriate well places and screws.	sqm	83	
		 appropriate wall plugs and screws. Install main GI runners (50x25mm) at 600mm c/c, suspended from the ceiling slab using hangers or directly fixed (as per design). Install cross tees to create a grid pattern, maintaining 600mm spacing. 			

		Check entire grid for level and			
		alignment.			
		 Cut gypsum boards to required 			
		sizes ensuring clean edges.			
		• Fix 9mm gypsum boards to the GI			
		framework using 25mm drywall			
		screws at 200mm spacing.			
		• Stagger board joints and leave a 2–			
		3mm gap between sheets for joint			
		treatment.			
		Cover joints and screw heads with			
		jointing compound.			
		Allow to dry and sand the surface			
		to achieve a smooth finish.			
		Apply one coat of acrylic filler			
		evenly over the entire ceiling.			
		After drying, sand the surface to			
		smoothen any imperfections.			
		Apply two coats of emulsion paint			
		(blue or white) allowing adequate			
		drying time between coats as per			
		manufacturer's instructions.			
		• Final finish should be uniform,			
		smooth, and free from brush marks			
		or patches.			
09	Grid	Supply and installation of Grid ceiling	sqm	34	
	Ceiling	with 50mm x 100mm GI box bar			
		complete with black colour car spray			
		paint as per the design and Details.			
		Method:			
		• Fix GI perimeter channels along the			
		Fix GI perimeter channels along the wells using expension holts.			
		walls using expansion bolts.			
		• Install hanger rods (8mm or 10mm			
		dia.) at 1200mm spacing.			
		Secure hanger rods using anchor			
		bolts and brackets.			
		• Ensure a stable and level			
		suspension system before			
		proceeding.			
		• Fix 50mm x 100mm GI box bars as			
		main supports at 600mm or			
		1200mm centers.			
		• Install cross members to form the			
		grid pattern.			
		Secure all connections using self-			
		tapping screws or welding ensuring			
		proper alignment.			
		Pre-install electrical wiring and			
		junction boxes for each downlight			
		location.			
		Apply anti-corrosion primer.			
		Apply black spray paint evenly			
		across the entire surface.			
1	i .	actobs are charte surface.			

		 Use multiple thin coats for smooth coverage. Allow proper drying time between coats. 			
10	Timber skirting	Supplying and fixing 18mm thick, 100mm high "Local Teak" skirting using brass nails/ adhesive, brass screws top finished with timber dowel and well sanded to receive smooth surface finish with approved quality water based one coat of wood primer and two coats and wood sealer.	m	35	
		 Measure and cut the Local Teak skirting boards to the required length, ensuring a tight, flush fit at corners and joints. Apply a thin, even layer of wood adhesive to the back of the skirting boards. Position the skirting board on the wall, ensuring it is level and flush with the floor. Fix the skirting to the wall using brass nails at regular intervals (approximately 300mm apart). Once the screws are installed, cover the screw heads with timber dowels for a clean finish. Apply wood filler to any visible gaps, nail holes, or imperfections in the skirting. Allow the filler to dry completely and then sand it down with fine-grit sandpaper for a smooth finish. Apply one coat of water-based wood primer. After the primer has dried and the surface is smooth, 			
11	Fluted	apply two coats of wood sealer. Supplying and fixing of Fluted Wave	sqm	29	
	Wave Panel	Panel with treated teak. Method: Measure the wall carefully, marking the locations for the fixing points or battens. Installation of Support Framework	- प्र		

				I	
		 Fix horizontal and vertical 50x50mm metal battens to the wall structure making a wave as per the project design. Install 6mm thk. MDF back panel to the framework. Use screws or anchors at appropriate intervals to ensure stability. Panel Installation Measure and cut the treated teak timber strips. Ensure the cut edges are smooth. Align the strips correctly and secure it using screws, nails, clips or adhesive to the prepared MDF back panel. Ensure that the strips are level and plumb. Ensure each is securely fastened and aligned correctly. Install corner profiles, edge trims, or covers to give the wall a clean and finished look. Secure these using the appropriate fixings. Surface finish with water base matching to the other WPC panels. If required, apply sealant or joint filler to ensure water resistance and 			
		improve the aesthetic finish of the			
		panel joints.			
12	Concealed recessed ceiling light	Supply and installation & wiring of Concealed recessed ceiling light (Prime cost: Rs. 6000.00)	Nr	14	
13	LED Surface mounted light	Supply and installation & wiring of 0'-6" x 0'-6" LED 18-watt ceiling mounted light fitting. (Prime cost: Rs.3400.00)	Nr	34	
14	Telephone Socket (intercom)	Supply and installation & wiring of Telephone Socket wired with a switch complete with accessories fixed on solid/partition wall	Nr	04	
15	Data Socket	Supply and installation & wiring of Data Socket wired with a switch complete with accessories fixed on solid/partition wall	Nr	08	

16	Power Socket outlet	Supply, Installation & wiring of power Socket Outlet Flush mounted 13 Amp switch socket outlet wired using 2x7/0.67 (2x7/.029) insulated copper wire & 1x7/0.67 (7/.029) copper earth wire in fully concealed/surface P.V.C. conduits (in radial circuit) through the ceiling, wall / partition up to the point including PVC trucking, outlet and other accessories up to the point.	Nr	15	
17	LED Strip Light	Supplying and installation of LED Strip lights with all the accessories as per the design. Specifications of LED Strip Lights Voltage – 12V DC Power Consumption - 9.6W/m (Medium brightness) LED Density - 60 LEDs/m (Standard brightness) Colour - Single Color: Warm White (3000K) Method: Attach LED strips to the on top and bottom of the fluted panel surfaces. Ensure even placement to avoid shadows or uneven lighting. Connect LED strips to the power supply using concealed wiring.	m	10	
		Provide electricity supply and all accessories for LED strip light.			
18	Wall painting in blue colour	Prepare and apply two coats of interior emulsion paint of blue color to the internal walls as per the design and details. Method: Remove dust, grease, and dirt from the walls/partitions using a damp cloth and mild detergent.	sqm	48	
		 Apply one coat of acrylic primer/sealer. Apply two coats evenly allowing the paint to dry completely as per the manufacturer's recommendation. 			
19	Wall painting in mustered yellow colour	Prepare and apply two coats of interior emulsion paint of mustered yellow color to the internal walls as per the design and details.	sqm	25	
		Method:			

20 Wall finishes with Titanium	 Remove dust, grease, and dirt from the walls/partitions using a damp cloth and mild detergent. Apply one coat of acrylic primer/sealer. Apply two coats evenly allowing the paint to dry completely as per the manufacturer's recommendation. Prepare and apply Titanium on the interior walls as per the design and details. Method: 	sqm	23	
	 Inspect the wall for any cracks, flaking paint, or unevenness. Clean the surface with a mild detergent solution to remove dust, grease, or contaminants. Let dry fully. Lightly sand the painted surface to create a key for the new finish to adhere (do not remove all the paint—just roughen the surface). Repair any cracks or holes using filler or putty. Let dry, then sand smooth. Apply one coat of bonding primer over the sanded painted wall. Allow to dry as per instructions. Mix titanium pigments with a cement-based or acrylic sealer. Apply a clear protective topcoat for added durability and a glossier 			
	finish. Total carried to Main Summary			

	Item	Description	Unit	Qty	Rate	Amount
В	Block - B			1		
01	Partial height (2700mm) solid partition	Supplying and installation of 9mm thk. Gypsum solid double partitions including framework and apply two coats of relevant color (mustered yellow/ white) paint finishes to surface over one coat of acrylic filler. Method:	sqm	16		
		 Installation of Aluminium Framework Fix the 50mm x 25mm U-Track on the floor and ceiling using appropriate wall plugs and screws at equal centers. Insert 50mm x 50mm C-Studs vertically at equal centers within the U-Track. Ensure the framework is properly aligned and leveled. Gypsum Board Installation Measure, cut, and position 9mm gypsum boards to fit the framework. Ensure boards flush with the column level. Secure the boards using drywall screws (every 300mm along the studs). Keep a 3mm gap between boards for joint filling. Apply jointing tape over board joints. Use acrylic filler to cover joints, screw holes, and imperfections. Allow the filler to dry completely before sanding. Smooth rough surfaces of and apply one coat of acrylic filler and two coats of relevant colour paint as top coat. 				
02	Partial height (2700mm) glass partition	Supplying and installation of 12mm thk. Tempered glass partition work with black powder coated "U" channel profile Aluminium framework and complete with neat finished. Method:	sqm	28		

Installation of Aluminium U-Channel Cut U-channel profiles to required lengths based on drawing. Fix aluminium U-channel to floor, ceiling, and side walls using countersunk screws and wall plugs at intervals of 300– 400mm. Use a laser or spirit level to ensure alignment. Insert rubber gaskets inside the channel to cushion the glass. Installation of Glass Carefully lift and insert 6mm tempered glass panels into the U-channel. Ensure even spacing and plumb alignment of glass panels. Use additional rubber gaskets or spacers to fix the glass securely and prevent rattling. Apply clear silicone sealant along the junctions (edges of glass and profile and between 2 glasses) to ensure stability and an aesthetic finish. Clean the glass surface and profile to remove dust, fingerprints, and sealant smudges. Conduct final inspection for level, alignment, and finish quality. Specification of Glass: Type: Clear tempered glass Thickness: 6mm Edge Finish: Polished edges Height: As per approved drawings **Specification of Aluminium Profile:** Type: "U" Channel Profile Material: Aluminium alloy (6063 T5) Finish: Black powder-coated Matt finished Size: - Internal width: 8mm (to accommodate glass + gasket) - Depth (height of leg): 25-

30mm

- Thickness of profile: 1.5-

		2mm (minimum)			
		2mm (minimum)Accessories: Rubber gaskets, corner joints, screws, wall plugs			
		 Specification of Sealant: Silicone clear sealant, non-acidic, anti-fungal 			
03	D1 – Glass door	Supply and fixing of size 900mm x 2100mm, 12mm thk. Tempered glass door and complete and finished with necessary door fittings and accessories and complete.	Nr	03	
		Method:			
		 Verify the door size (900 x 2100mm) and inspect the glass for damage. Ensure factory-prepared holes/cutouts for fittings are present and accurate. Attach top and bottom patch fittings to the glass door using rubber gaskets. Fix door handles with proper alignment using pre-drilled holes. Install locking system and align the strike plate location on the adjacent partition or floor. Lift the glass door panel and position it between the pivot points (top and bottom). Check for smooth swinging 			
04	Carpeting	operation and correct alignment. Supplying and installation of	sqm	32	
07	(Gray color Carpet)	approved gray colour and high end cut pile carpet with a minimum of 20oz., suitable for heavy use. Complete and finish as per the design.	sqiii	- 5 <u>2</u>	
		Method:			
		 Measure and mark the installation area according to the approved design. Cut the carpet to the required dimensions, allowing extra material for trimming. Apply the high-strength adhesive uniformly over the cut and polished cement floor using a trowel. 			

05	Vinyl	 Carefully lay the carpet onto the adhesive, ensuring proper alignment and avoiding bubbles or wrinkles. Ensure proper alignment of carpet edges to create seamless joints. Use a seam roller to blend the joints and maintain a uniform appearance. Trim excess material along walls and doorways for a neat finish. Install edge trims or transition strips where required. Specification of Floor Carpet Carpet Type: High-end loop pile carpet Color: Approved gray colour Pile Weight: Minimum 20oz Carpet Thickness: 5mm Padding: Single-padded Subfloor: Existing cut and polished cement floor surface Supplying and laying of 3mm thk. approved vinyl flooring design, all 	sqm	43	
		joints in neat finished. Complete and finish as per the design. (Prime cost: Rs. 600 per sq.ft)			
		Method:			
		Inspect the subfloor to ensure it is clean, smooth, dry, and level. Paragraphy and debries are debries.			
		• Remove any debris, old adhesives, paint, or contaminants.			
		Apply self-leveling compound if necessary to correct floor unevenness.			
		• Moisture content of subfloor should be below 3%.			
		• Apply adhesive evenly using a notched trowel to the subfloor in sections.			
		Allow the adhesive to tack-up as per manufacturer's manufactu			
		recommendations (open time).Carefully lay the vinyl into the adhesive.			
		• Press and smooth the vinyl to remove air pockets.			
		• Use a 50–75 kg floor roller to bond the flooring evenly and			
		eliminate bubbles.Maintain tight, consistent joints			

		between sheets for a seamless finish.			
06	Gypsum concealed type Ceiling	Supply and installation of 9mm thick plain Gypsum ceiling with 50mm x 25mm GI box frame work complete with two coats of emulsion painting (gray/ white) finishes to surface over one coat of acrylic filler. Rate shall include for hanging of ceiling with thread bars in order.	sqm	73	
		Method:			
		 Installation of Framework Fix perimeter channels on walls at the marked ceiling level using appropriate wall plugs and screws. Install main GI runners (50x25mm) at 600mm c/c, suspended from the ceiling slab using hangers or directly fixed (as per design). Install cross tees to create a grid pattern, maintaining 600mm spacing. Check entire grid for level and alignment. Cut gypsum boards to required sizes ensuring clean edges. Fix 9mm gypsum boards to the GI framework using 25mm drywall screws at 200mm spacing. Stagger board joints and leave a 2–3mm gap between sheets for joint treatment. Cover joints and screw heads with jointing compound. Allow to dry and sand the surface to achieve a smooth finish. Apply one coat of acrylic filler evenly over the entire ceiling. After drying, sand the surface to smoothen any imperfections. Apply two coats of emulsion paint (gray/ white) allowing adequate drying time between coats as per manufacturer's instructions. Final finish should be uniform, 			
		smooth, and free from brush marks or patches.			

07	TP: 1	0 1 1 10 40 314		27	
07	Timber skirting	Supplying and fixing 18mm thick, 100mm high "Local Teak" skirting using brass nails/ adhesive, brass screws top finished with timber dowel and well sanded to receive smooth surface finish with approved quality water based one coat of wood primer and two coats and wood sealer. Method: Measure and cut the Local Teak skirting boards to the required length, ensuring a tight, flush fit at corners and joints. Apply a thin, even layer of wood adhesive to the back of the skirting boards. Position the skirting board on the wall, ensuring it is level and flush with the floor. Fix the skirting to the wall using brass nails at regular intervals (approximately 300mm apart). Once the screws are installed, cover the screw heads with timber dowels for a clean finish. Apply wood filler to any visible gaps, nail holes, or imperfections in the skirting. Allow the filler to dry completely and then sand it down with fine-grit sandpaper for a smooth finish. Apply one coat of water-based wood primer. After the primer	m	36	
		has dried and the surface is smooth, apply two coats of wood sealer.			
08	Concealed recessed ceiling light	Supply and installation of Concealed recessed ceiling light (Prime cost: Rs.6000.00)	Nr	16	
09	Telephone Socket (intercom)	Supply and installation & wiring of Telephone Socket wired with a switch complete with accessories fixed on solid/partition wall	Nr	19	
10	Data Socket	Supply and installation & wiring of Data Socket wired with a switch	Nr	21	

		1		1	1
		complete with accessories fixed on			
	_	solid/partition wall		40	
11	Power	Supply, Installation & wiring of	Nr	42	
	Socket	power Socket Outlet Flush mounted			
	outlet	13 Amp switch socket outlet wired			
		using $2x7/0.67$ (2x7/.029) insulated			
		copper wire & 1x7/0.67 (7/.029)			
		copper earth wire in fully			
		concealed/surface P.V.C. conduits			
		(in radial circuit) through the			
		ceiling, wall / partition up to the			
		point including PVC trucking, outlet			
10	XX7 11	and other accessories up to the point.		<i>[</i> 1	
12	Wall	Prepare and apply two coats of	sqm	51	
	painting in	interior emulsion paint of gray color			
	gray colour	to the internal walls as per the			
		design and details.			
		Method:			
		Method.			
		Remove dust, grease, and dirt			
		from the walls/partitions using a			
		damp cloth and mild detergent.			
		 Apply one coat of acrylic 			
		primer/sealer.			
		 Apply two coats evenly allowing 			
		the paint to dry completely as			
		per the manufacturer's			
		recommendation.			
13	Wall	Prepare and apply two coats of	sqm		
13	painting in	interior emulsion paint of mustered	sqiii		
	mustered	yellow color to the internal walls as			
	yellow	per the design and details.			
	colour	per une design une detunis.			
	0.000	Method:			
		Remove dust, grease, and dirt			
		from the walls/partitions using a			
		damp cloth and mild detergent.			
		Apply one coat of acrylic			
		primer/sealer.			
		Apply two coats evenly allowing			
		the paint to dry completely as			
		per the manufacturer's			
		recommendation.			
14	Wall	Supplying of Wall Sticker as per the	PS		10,000.00
	Sticker	design.			
		Total carried to Main Summary			

	Item	Description	Unit	Qty	Rate	Amount
С	Block - C					
01	Full height solid partition	Supplying and installation of 9mm thk. Gypsum solid double partitions including framework and apply two coats of relevant color (misty green/gray) paint finishes to surface over one coat of acrylic filler.	sqm	10		
		Method:				
		 Installation of Aluminium Framework Fix the 50mm x 25mm U-Track on the floor and ceiling using appropriate wall plugs and screws at equal centers. Insert 50mm x 50mm C-Studs vertically at equal centers within the U-Track. Ensure the framework is properly aligned and leveled. 				
		 Gypsum Board Installation Measure, cut, and position 9mm gypsum boards to fit the framework. Ensure boards flush with the column level. Secure the boards using drywall screws (every 300mm along the studs). Keep a 3mm gap between boards for joint filling. Apply jointing tape over board joints. Use acrylic filler to cover joints, screw holes, and imperfections. Allow the filler to dry completely before sanding. Smooth rough surfaces of and apply one coat of acrylic filler and two coats of relevant colour paint as top coat. 				
02	Full height glass partition	Supplying and installation of 12mm thk. Tempered glass partition work with black powder coated "U" channel profile Aluminium framework and complete with neat finished.	sqm	22		
		Method:				
		Installation of Aluminium U-Channel • Cut U-channel profiles to				

	•
required lengths based on drawing. • Fix aluminium U-channel to floor, ceiling, and side walls using countersunk screws and wall plugs at intervals of 300–400mm. • Use a laser or spirit level to ensure alignment. • Insert rubber gaskets inside the channel to cushion the glass.	
 Installation of Glass Carefully lift and insert 6mm tempered glass panels into the Uchannel. Ensure even spacing and plumb alignment of glass panels. Use additional rubber gaskets or spacers to fix the glass securely and prevent rattling. Apply clear silicone sealant along the junctions (edges of glass and profile and between 2 glasses) to ensure stability and an aesthetic finish. Clean the glass surface and profile to remove dust, fingerprints, and sealant smudges. Conduct final inspection for level, alignment, and finish quality. 	
 Specification of Glass: Type: Clear tempered glass Thickness: 6mm Edge Finish: Polished edges Height: As per approved drawings 	
 Specification of Aluminium Profile: Type: "U" Channel Profile Material: Aluminium alloy (6063 T5) Finish: Black powder-coated Matt finished Size: Internal width: 8mm (to accommodate glass + gasket) Depth (height of leg): 25–30mm Thickness of profile: 1.5–2mm (minimum) Accessories: Rubber gaskets, corner joints, screws, wall plugs 	
Specification of Sealant:	

		Silicone clear sealant, non-acidic, anti-fungal			
03	Partial height (2700mm) solid partition		sqm	20	
		 Keep a 3mm gap between boards for joint filling. Apply jointing tape over board joints. Use acrylic filler to cover joints, screw holes, and imperfections. Allow the filler to dry completely before sanding. Smooth rough surfaces of and apply one coat of acrylic filler and two coats of relevant colour paint as top coat. 			
04	Partial height (2700mm) glass partition	Supplying and installation of 12mm thk. Tempered glass partition work with black powder coated "U" channel profile Aluminium framework and complete with neat finished. Method:	sqm	11	
		Installation of Aluminium U-Channel ◆ Cut U-channel profiles to required lengths based on			

drawing. Fix aluminium U-channel to floor, ceiling, and side walls using countersunk screws and wall plugs at intervals of 300-400mm. Use a laser or spirit level to ensure alignment. Insert rubber gaskets inside the channel to cushion the glass. Installation of Glass Carefully lift and insert 6mm tempered glass panels into the Uchannel. Ensure even spacing and plumb alignment of glass panels. Use additional rubber gaskets or spacers to fix the glass securely and prevent rattling. Apply clear silicone sealant along the junctions (edges of glass and profile and between 2 glasses) to ensure stability and an aesthetic finish. Clean the glass surface and profile to remove dust, fingerprints, and sealant smudges. Conduct final inspection for level, alignment, and finish quality. Specification of Glass: Type: Clear tempered glass Thickness: 6mm Edge Finish: Polished edges Height: As per approved drawings Specification of Aluminium Profile: Type: "U" Channel Profile Material: Aluminium alloy (6063 Finish: Black powder-coated Matt finished Size: - Internal width: 8mm (to accommodate glass + gasket) - Depth (height of leg): 25–30mm - Thickness of profile: 1.5–2mm (minimum) Accessories: Rubber gaskets, corner joints, screws, wall plugs

Silicone clear sealant, non-acidic,

Specification of Sealant:

		anti-fungal			
05	D1 – Glass door	Supply and fixing of size 900mm x 2100mm, 6mm thk. Tempered glass door and complete and finished with necessary door fittings and accessories and complete.	Nr	03	
		Method:			
		 Verify the door size (900 x 2100mm) and inspect the glass for damage. Ensure factory-prepared holes/cutouts for fittings are present and accurate. Attach top and bottom patch fittings to the glass door using rubber gaskets. Fix door handles with proper alignment using pre-drilled holes. Install locking system and align the strike plate location on the adjacent partition or floor. Lift the glass door panel and position it between the pivot points (top and bottom). Check for smooth swinging 			
		operation and correct alignment.			
06	D2 – Solid door	Supply and fixing of size 900mm x 2100mm 9mm thk. Gypsum solid double partitioned door including framework with necessary door fittings and accessories and apply two coats of relevant color (gray) paint finishes to surface over one coat of acrylic filler and complete.	Nr	01	
07	Carpeting (Gray color Carpet)	Supplying and installation of approved gray colour and high end cut pile carpet with a minimum of 20oz., suitable for heavy use. Complete and finish as per the design.	sqm	31	
		Method:			
		 Measure and mark the installation area according to the approved design. Cut the carpet to the required dimensions, allowing extra material for trimming. Apply the high-strength adhesive uniformly over the cut and polished cement floor using a trowel. Carefully lay the carpet onto the 			

	1				1
		 adhesive, ensuring proper alignment and avoiding bubbles or wrinkles. Ensure proper alignment of carpet edges to create seamless joints. Use a seam roller to blend the joints and maintain a uniform appearance. Trim excess material along walls and doorways for a neat finish. Install edge trims or transition strips where required. Specification of Floor Carpet			
		Carpet Type: High-end loop pile carpet Color: Approved gray colour			
		Pile Weight: Minimum 20oz			
		Carpet Thickness: 5mm			
		Padding: Single-padded Subfloor: Existing cut and polished			
		cement floor surface			
08	Vinyl flooring	Supplying and laying of 3mm thk. approved vinyl flooring design, all joints in neat finished. Complete and finish as per the design. (Prime cost: Rs. 600 per sq.ft)	sqm	44	
		Method:			
		 Inspect the subfloor to ensure it is clean, smooth, dry, and level. Remove any debris, old adhesives, paint, or contaminants. Apply self-leveling compound if necessary to correct floor unevenness. Moisture content of subfloor should be below 3%. Apply adhesive evenly using a notched trowel to the subfloor in sections. Allow the adhesive to tack-up as per manufacturer's recommendations (open time). Carefully lay the vinyl into the adhesive. 			
		 Press and smooth the vinyl to remove air pockets. Use a 50–75 kg floor roller to 			
		 bond the flooring evenly and eliminate bubbles. Maintain tight, consistent joints between sheets for a seamless 			
00	Comm	finish.		72	
09	Gypsum concealed	Supply and installation of 9mm thick plain Gypsum ceiling with 50mm x	sqm	73	
-	_	Dogo 24 of		_	

	type Ceiling	25mm GI box frame work complete with two coats of emulsion painting			
	S	(white) finishes to surface over one			
		coat of acrylic filler. Rate shall include for hanging of ceiling with thread bars			
		in order.			
		Method:			
		Installation of Framework			
		• Fix perimeter channels on walls at			
		the marked ceiling level using appropriate wall plugs and screws.			
		 Install main GI runners 			
		(50x25mm) at 600mm c/c,			
		suspended from the ceiling slab			
		using hangers or directly fixed (as per design).			
		• Install cross tees to create a grid			
		pattern, maintaining 600mm			
		spacing.Check entire grid for level and			
		alignment.			
		Cut gypsum boards to required			
		sizes ensuring clean edges.Fix 9mm gypsum boards to the GI			
		framework using 25mm drywall			
		screws at 200mm spacing.			
		• Stagger board joints and leave a 2–3mm gap between sheets for joint			
		treatment.			
		Cover joints and screw heads with icinting compound			
		jointing compound.Allow to dry and sand the surface			
		to achieve a smooth finish.			
		Apply one coat of acrylic filler avanta avantha anting cailing			
		evenly over the entire ceiling.After drying, sand the surface to			
		smoothen any imperfections.			
		• Apply two coats of emulsion paint (blue or white) allowing adequate			
		drying time between coats as per			
		manufacturer's instructions.			
		• Final finish should be uniform, smooth, and free from brush marks			
		or patches.			
10	Timber	Supplying and fixing 18mm thick,	m	36	
	skirting	100mm high "Local Teak" skirting using brass nails/ adhesive, brass			
		screws top finished with timber dowel			
		and well sanded to receive smooth			
		surface finish with approved quality			
		water based one coat of wood primer and two coats and wood sealer.			
		3.6			
		Method:			

		 Measure and cut the Local Teak skirting boards to the required length, ensuring a tight, flush fit at corners and joints. Apply a thin, even layer of wood adhesive to the back of the skirting boards. Position the skirting board on the wall, ensuring it is level and flush with the floor. Fix the skirting to the wall using brass nails at regular intervals (approximately 300mm apart). Once the screws are installed, cover the screw heads with timber dowels for a clean finish. Apply wood filler to any visible gaps, nail holes, or imperfections in the skirting. Allow the filler to dry completely and then sand it down with finegrit sandpaper for a smooth finish. Apply one coat of water-based wood primer. After the primer has dried and the surface is smooth, apply two coats of wood sealer. 			
11	Concealed recessed ceiling light	Supply and installation of Concealed recessed ceiling light (Prime cost: Rs.6000.00)	Nr	21	
12	Telephone Socket (intercom)	Supply and installation & wiring of Telephone Socket wired with a switch complete with accessories fixed on solid/partition wall	Nr	07	
13	Data Socket	Supply and installation & wiring of Data Socket wired with a switch complete with accessories fixed on solid/partition wall	Nr	15	
14	Power Socket outlet	Supply, Installation & wiring of power Socket Outlet Flush mounted 13 Amp switch socket outlet wired using 2x7/0.67 (2x7/.029) insulated copper wire & 1x7/0.67 (7/.029) copper earth wire in fully concealed/surface P.V.C. conduits (in radial circuit) through the ceiling, wall / partition up to the point including PVC trucking, outlet and other accessories up to the point.	Nr	25	
15	LED Strip Light	Supplying and installation of LED Strip lights with all the accessories as	m	08	

		per the design.			
		Specifications of LED Strip Lights Voltage – 12V DC Power Consumption - 9.6W/m (Medium brightness) LED Density - 60 LEDs/m (Standard brightness) Colour - Single Color: Warm White (3000K)			
		Method:			
		 Attach LED strips to the on top and bottom of the fluted panel surfaces. Ensure even placement to avoid shadows or uneven lighting. Connect LED strips to the power supply using concealed wiring. 			
		Provide electricity supply and all accessories for LED strip light.			
16	Wall painting in gray colour	Prepare and apply two coats of interior emulsion paint of gray color to the internal walls as per the design and details.	sqm	25	
		Method:			
		 Remove dust, grease, and dirt from the walls/partitions using a damp cloth and mild detergent. Apply one coat of acrylic primer/sealer. Apply two coats evenly allowing the paint to dry completely as per the manufacturer's recommendation. 			
17	Wall painting in misty green colour	Prepare and apply two coats of interior emulsion paint of misty green color to the internal walls as per the design and details.	sqm	14	
		Method:			
		 Remove dust, grease, and dirt from the walls/partitions using a damp cloth and mild detergent. Apply one coat of acrylic primer/sealer. Apply two coats evenly allowing the paint to dry completely as per the manufacturer's recommendation. 			

18	Wall finishes with	Prepare and apply Titanium on the interior walls as per the design and details	sqm	27	
	finishes with Titanium	 interior walls as per the design and details. Method: Inspect the wall for any cracks, flaking paint, or unevenness. Clean the surface with a mild detergent solution to remove dust, grease, or contaminants. Let dry fully. Lightly sand the painted surface to create a key for the new finish to adhere (do not remove all the paint—just roughen the surface). Repair any cracks or holes using filler or putty. Let dry, then sand smooth. Apply one coat of bonding primer over the sanded painted wall. Allow to dry as per instructions. Mix titanium pigments with a cement-based or acrylic sealer. Apply multiple thin coats. Apply a clear protective topcoat 			
		for added durability and a glossier finish. Total carried to Main Summary			

	Item	Description	Unit	Qty	Rate	Amount
D	Block – D	-				
01	Painted pergolas	Prepare and apply two coats of interior emulsion paint of brown color to the pergolas walls as per the design and details.	sqm	30.00		
		Method:				
		 Remove dust, grease, and dirt from the pergolas. Apply one coat of acrylic primer/sealer. Apply two coats evenly allowing the paint to dry completely as per the manufacturer's recommendation. 				
02	Painted strips	Prepare and apply two coats of interior emulsion paint of brown color to the strips marked on walls as per the design and details.	sqm	2.00		
		Method:				
		 Remove dust, grease, and dirt from the wall. Mark the areas to be painted as continuation of pergolas on the wall referring the drawing. Apply one coat of acrylic primer/sealer. Apply two coats evenly allowing the paint to dry completely as per the manufacturer's recommendation. 				
03	Words	Write the given list of words on the pergolas as per the design and details. Method:	PS			75,000.00
		 Remove dust, grease, and dirt from the pergolas. Mark the relevant words on pergolas referring the drawing. Write the words using white colour paint (if needed, double coat evenly allowing the paint to dry completely as per the manufacturer's recommendation). Total carried to Main Summary 				

NOTE -

- In case of alterations to the given method statement, Contractor must obtain/ submit new method statement for prior approval.
- Take measurements on site before commencing the work.
- When supplying electricity/power, consultation of an Electrical Engineer is a must.

CONSTRUCTION OF PARTITIONING WORK AT THE NEW BUILDING OF THE DEPARTMENT OF ESTATATE MANAGEMENT AND VALUATION, FACULTY OF MANAGEMENT STUDIES AND COMMERCE

Grand Summery

Item No	Description	Amount (Rs)
A	Total carried to Main Summary from Block - A	
В	Total carried to Main Summary from Block - B	
С	Total carried to Main Summary from Block - C	
D	Total carried to Main Summary from Block - D	
	Total Amount	
	Discount if any	
	Sub Total	
	Add 18% VAT amount	
	Grand Total with VAT	

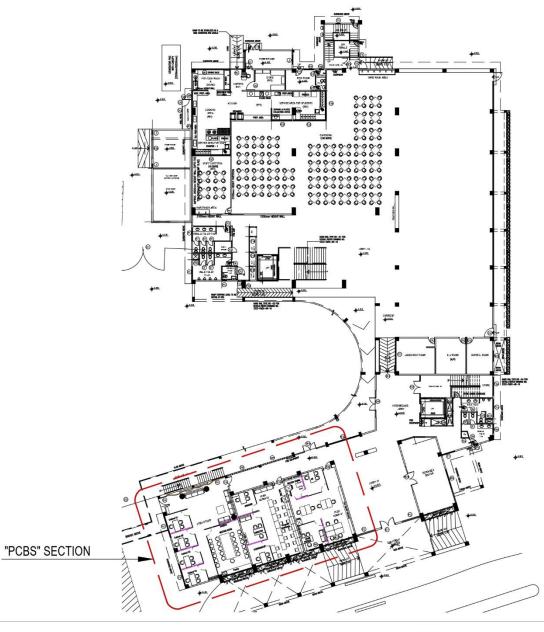
	Grand Total with VAT		
Amount in	words :		
VAT Amou	ant in words :		
VAT Regis	tration No:		
Signature o	f Contractor:		
Witnesses:			
Name:		Name:	
Address:		Address:	
Signature:		Signature:	
			LBIDD

Section - 8

DRAWINGS

PROPOSED INTERIOR FOR POSTGRADUATE CENTER FOR BUSINESS STUDIES USJ/FMSC/ID/008





"PCBS" SECTION - GROUND FLOOR

This drawing is to set forth design intent only. All dimensions are to be verified on site. Figured dimensions are to be taken in preference to scale. Contractors shall verify and be responsible for all dimensions and conditions on the job and FMSC must be notified of any discrepancy, mission or variation from the dimensions and conditions shown by these drawings prior to the commencement of any work.

GENERAL NOTES

VERIFY MEASUREMENTS ON SITE BEFORE COMMENCING THE WORK PROJECT

PROPOSED INTERIOR FOR POSTGRADUATE

DRAWING TITLE

LOCATION PLAN

 DRAWING NO
 DATE ISSUED

 A

 JOB NO: 008
 SCALE: NTS

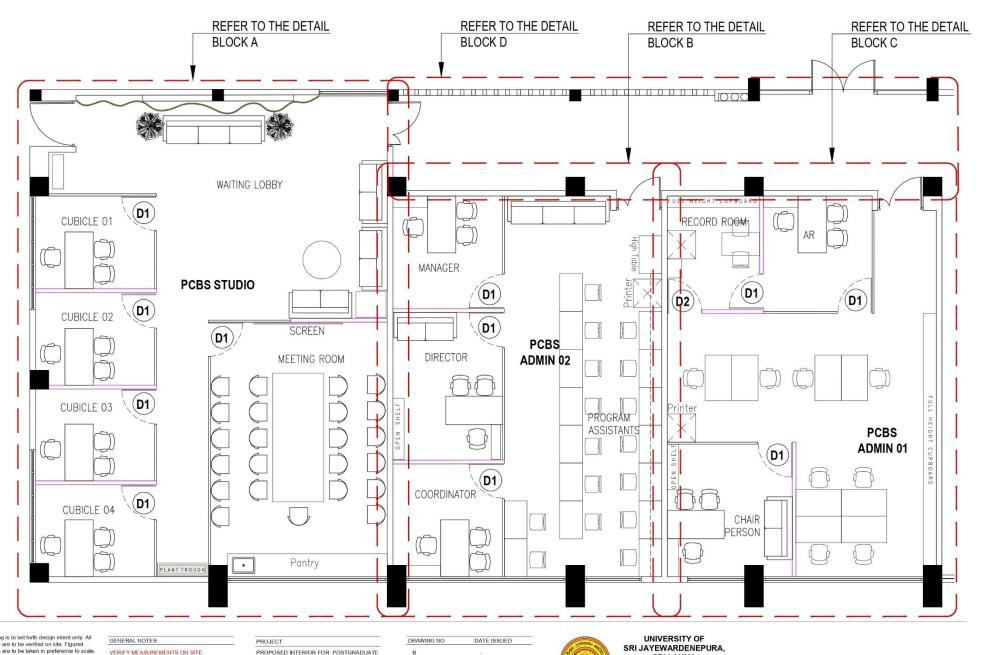
PREPARED BY: MW CHECKED BY: CU



UNIVERSITY OF SRI JAYEWARDENEPURA, SRI LANKA

FACULTY OF MANAGEMENT STUDIES & COMMERCE

DR. CHAMEERA UDAWATTHA



BEFORE COMMENCING THE WORK

PROPOSED INTERIOR FOR POSTGRADUATE

DRAWING TITLE

INFORMATION PLAN - OVERALL

JOB NO: 008 SCALE: 1:50

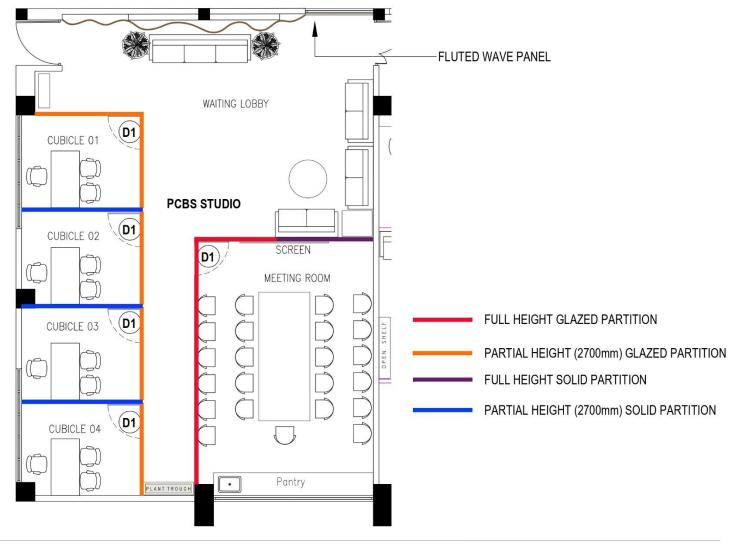
PREPARED BY: MW CHECKED BY: CU



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FACULTY OF MANAGEMENT STUDIES & COMMERCE

DR. CHAMEERA UDAWATTHA



GENERAL NOTES

VERIFY MEASUREMENTS ON SITE BEFORE COMMENCING THE WORK

PROJECT

PROPOSED INTERIOR FOR POSTGRADUATE

DRAWING TITLE

INFORMATION & SETTING OUT PLAN -

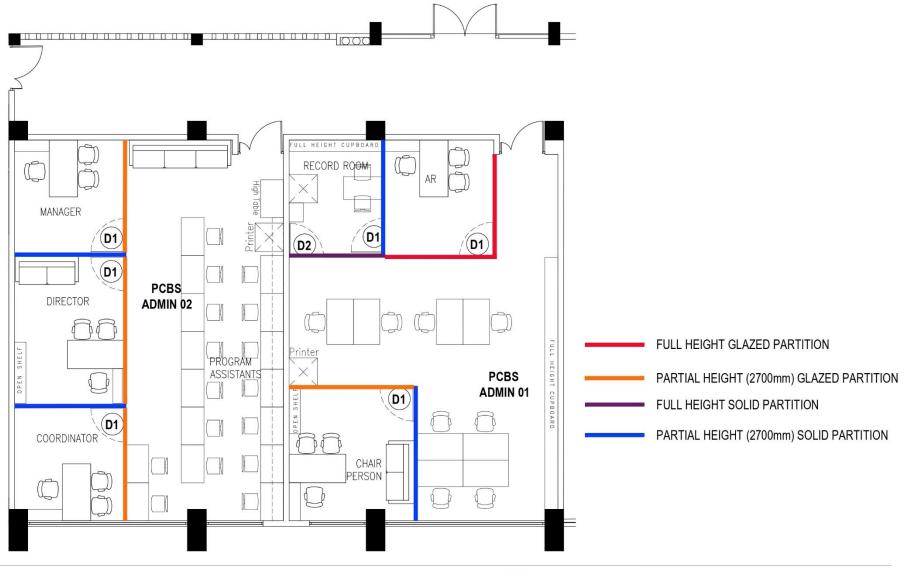
PREPARED BY: MW CHECKED BY: CU



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DR. CHAMEERA UDAWATTHA



This drawing is to set forth design intent only. All dimensions are to be taken in preference to scale. Contractors shall verify and be responsible for all dimensions and conditions on the job and FMSC must be notified of any discrepancy, omission or variation from the dimensions and conditions on shown by these drawings prior to the

GENERAL NOTES

VERIFY MEASUREMENTS ON SITE

PROJEC

PROPOSED INTERIOR FOR POSTGRADUATE

DRAWING TITLE

INFORMATION & SETTING OUT PLAN -BLOCK B, BLOCK C & BLOCK D

CHECKED BY: CU

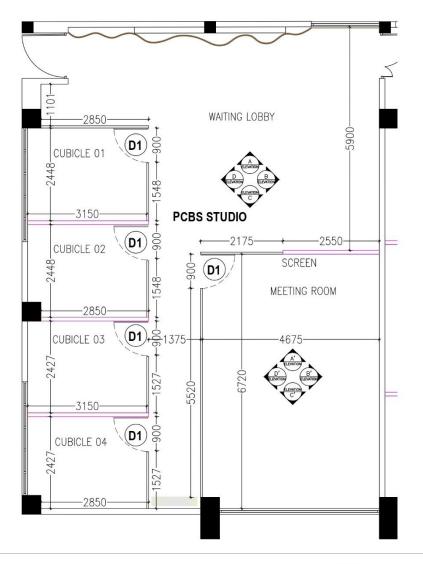
PREPARED BY: MW



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DR. CHAMEERA UDAWATTHA



GENERAL NOTES

VERIFY MEASUREMENTS ON SITE BEFORE COMMENCING THE WORK

PROJECT

PROPOSED INTERIOR FOR POSTGRADUATE CENTER FOR BUSINESS STUDIES

DRAWING TITLE

SETTING OUT PLAN - BLOCK A

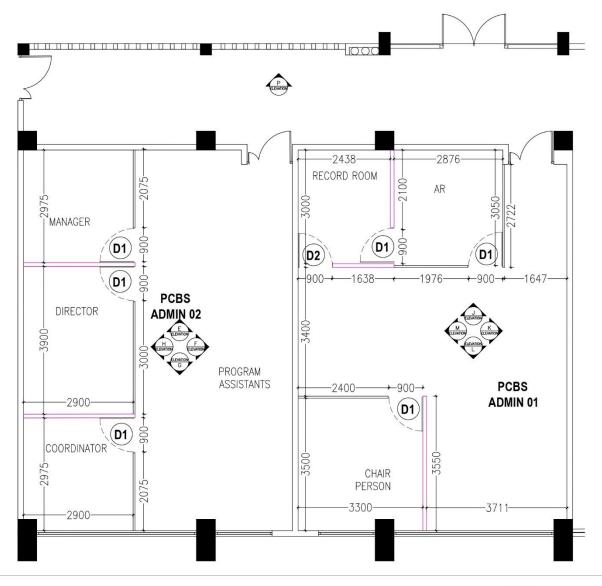
DRAWING NO	DATE ISSUED
002A	
JOB NO: 008	SCALE: 1:50
PREPARED BY: MW	CHECKED BY: CU



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FACULTY OF MANAGEMENT STUDIES & COMMERCE

DR. CHAMEERA UDAWATTHA



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GENERAL NOTES

VERIFY MEASUREMENTS ON SITE BEFORE COMMENCING THE WORK

PROJEC

PROPOSED INTERIOR FOR POSTGRADUATE

DRAWING TITLE

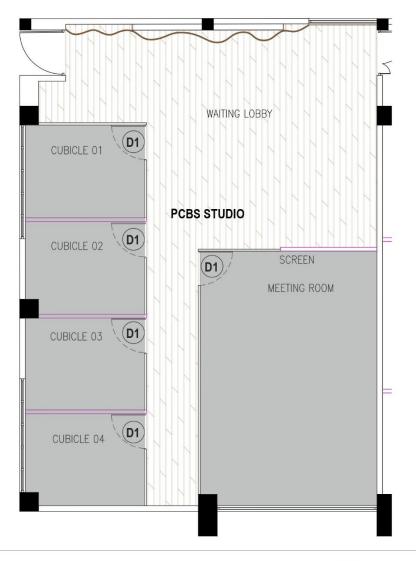
SETTING OUT PLAN - BLOCK B, BLOCK C &



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VINYL FLOORING ON EXISTING CUT & POLISH CEMENT FLOOR

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GENERAL NOTES

VERIFY MEASUREMENTS ON SITE BEFORE COMMENCING THE WORK PROJECT

PROPOSED INTERIOR FOR POSTGRADUATE

DRAWING TITLE

FLOOR FINISHES - BLOCK A

DRAWING NO	DATE ISSUED
003A	-
JOB NO: 008	SCALE: 1:50

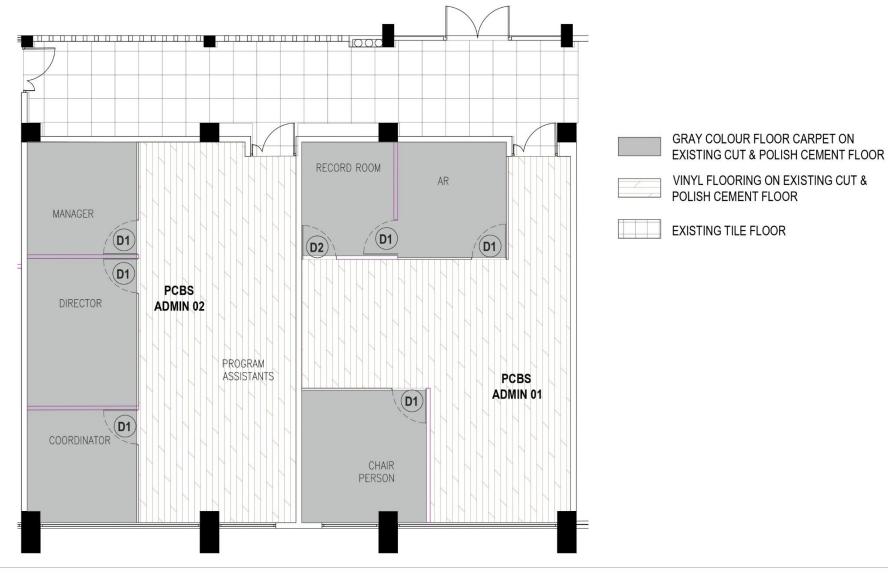
PREPARED BY: MW CHECKED BY: CU



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GENERAL NOTES

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PROPOSED INTERIOR FOR POSTGRADUATE

DRAWING TITLE

FLOOR FINISHES - BLOCK B, BLOCK C

 DRAWING NO
 DATE ISSUED

 003B

 JOB NO: 008
 SCALE: 1:50

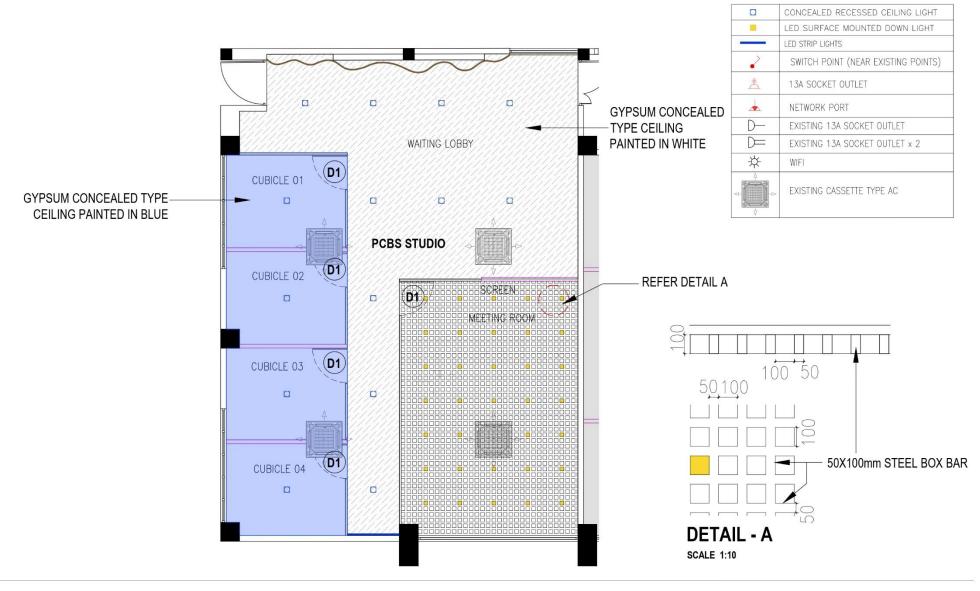
PREPARED BY: MW CHECKED BY: CU



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GENERAL NOTES

VERIFY MEASUREMENTS ON SITE BEFORE COMMENCING THE WORK

PROJECT

PROPOSED INTERIOR FOR POSTGRADUATE

DRAWING TITLE

CEILING FINISHES & LIGHTING LAYOUT-

 DRAWING NO
 DATE ISSUED

 004A

 JOB NO: 008
 SCALE: 1:50

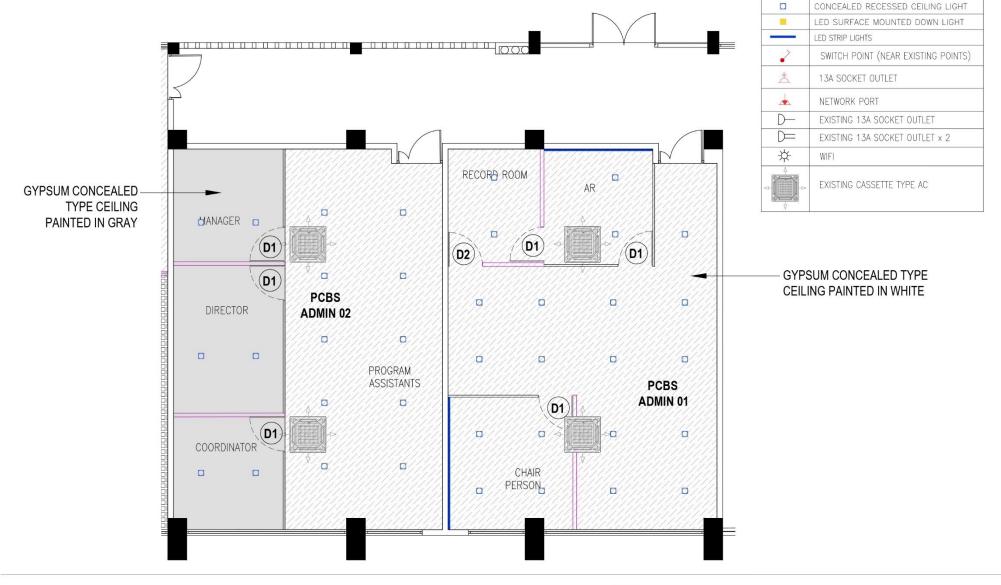
PREPARED BY: MW CHECKED BY: CU



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GENERAL NOTES

VERIFY MEASUREMENTS ON SITE BEFORE COMMENCING THE WORK PROJEC

PROPOSED INTERIOR FOR POSTGRADUATE CENTER FOR BUSINESS STUDIES

DRAWING TITLE

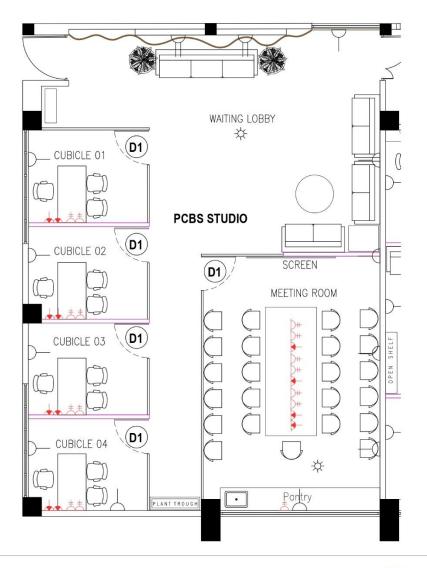
CEILING FINISHES & LIGHTING LAYOUT - BLOCK B, BLOCK C & BLOCK D

PREPARED BY: MW CHECKED BY: CU

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	CONCEALED RECESSED CEILING LIGHT
<u> </u>	LED SURFACE MOUNTED DOWN LIGHT
	LED STRIP LIGHTS
>	SWITCH POINT (NEAR EXISTING POINTS)
土	13A SOCKET OUTLET
	NETWORK PORT
D—	EXISTING 13A SOCKET OUTLET
D	EXISTING 13A SOCKET OUTLET x 2
*	WIFI
	EXISTING CASSETTE TYPE AC

GENERAL NOTES

VERIFY MEASUREMENTS ON SITE BEFORE COMMENCING THE WORK

PROJECT

PROPOSED INTERIOR FOR POSTGRADUATE CENTER FOR BUSINESS STUDIES

DRAWING TITLE

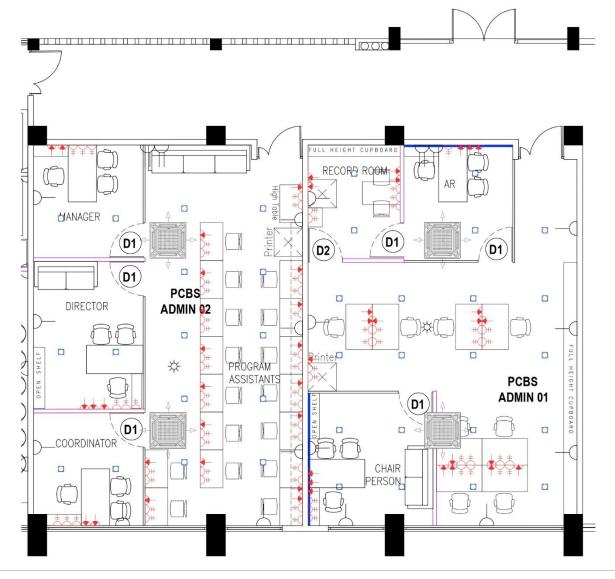
ELECTRICAL LAYOUT - BLOCK A



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	CONCEALED RECESSED CEILING LIGHT
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	LED STRIP LIGHTS
>	SWITCH POINT (NEAR EXISTING POINTS)
土	13A SOCKET OUTLET
	NETWORK PORT
D-	EXISTING 13A SOCKET OUTLET
D	EXISTING 13A SOCKET OUTLET x 2
*	WIFI
A	EXISTING CASSETTE TYPE AC

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GENERAL NOTES

VERIFY MEASUREMENTS ON SITE BEFORE COMMENCING THE WORK PROJECT

PROPOSED INTERIOR FOR POSTGRADUATE CENTER FOR BUSINESS STUDIES

DRAWING TITLE

ELECTRICAL LAYOUT - BLOCK B, BLOCK C

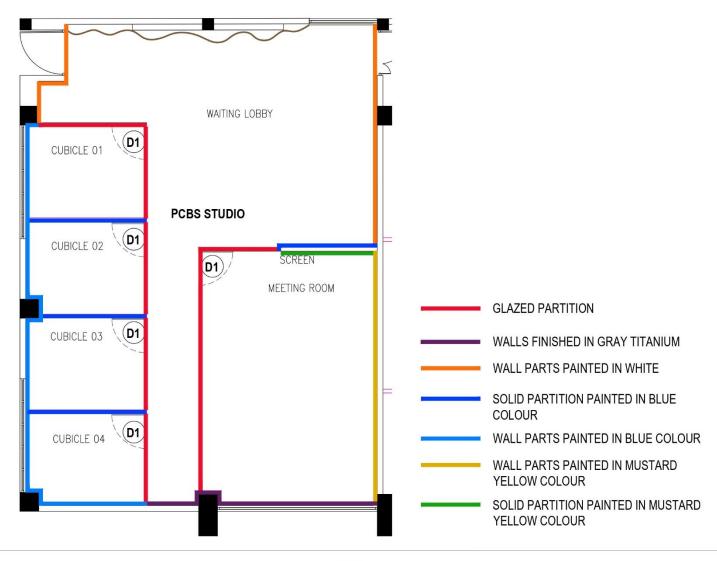
PREPARED BY: MW CHECKED BY: CU



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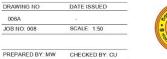
VERIFY MEASUREMENTS ON SITE BEFORE COMMENCING THE WORK

PROJECT

PROPOSED INTERIOR FOR POSTGRADUATE

DRAWING TITLE

PARTITION & WALL FINISHES LAYOUT -

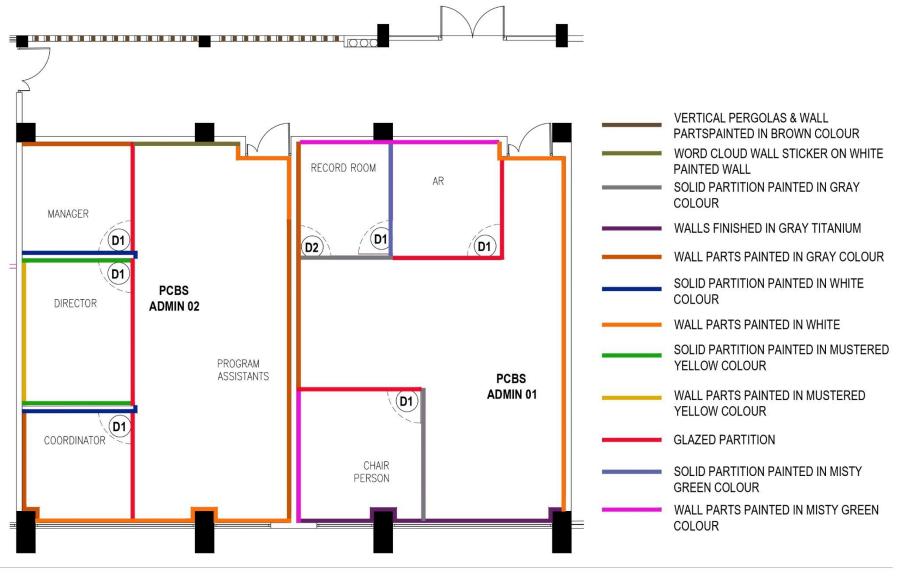




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GENERAL NOTES

VERIFY MEASUREMENTS ON SITE BEFORE COMMENCING THE WORK PROJEC

PROPOSED INTERIOR FOR POSTGRADUATE CENTER FOR BUSINESS STUDIES

PARTITION & WALL FINISHES LAYOUT -BLOCK B, BLOCK C & BLOCK D
 DRAWING NO
 DATE ISSUED

 006B

 JOB NO: 008
 SCALE: 1:50

CHECKED BY: CU

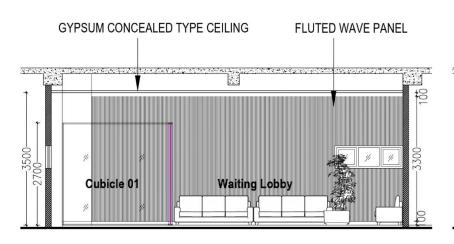
PREPARED BY: MW

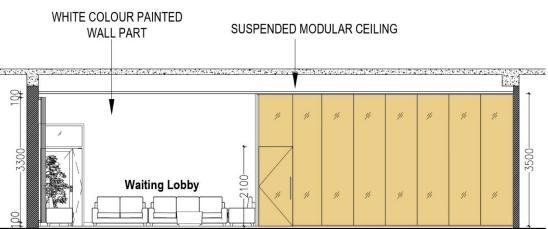


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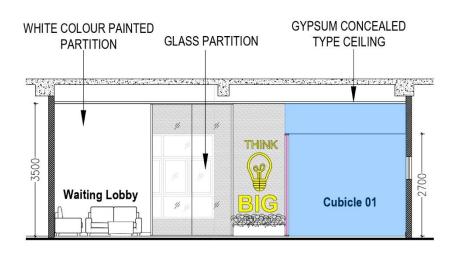
DR. CHAMEERA UDAWATTHA

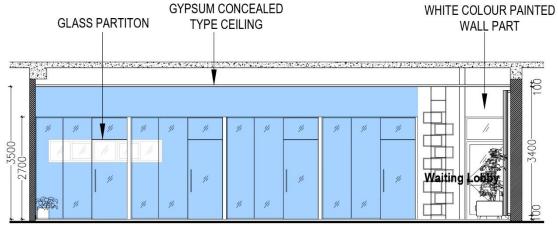




SECTIONAL ELEVATION - A

SECTIONAL ELEVATION - B





SECTIONAL ELEVATION - C

SECTIONAL ELEVATION - D

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GENERAL NOTES VERIFY MEASUREMENTS ON SITE BEFORE COMMENCING THE WORK PROPOSED INTERIOR FOR POSTGRADUATE CENTER FOR BUSINESS STUDIES

DRAWING TITLE

SECTIONAL ELEVATIONS - BLOCK A

DRAWING NO DATE ISSUED JOB NO: 008 SCALE: 1:50

CHECKED BY: CU

007

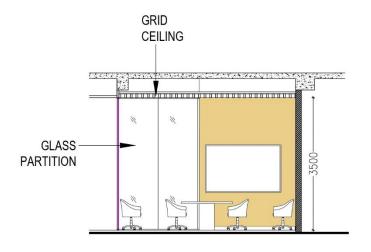
PREPARED BY: MW



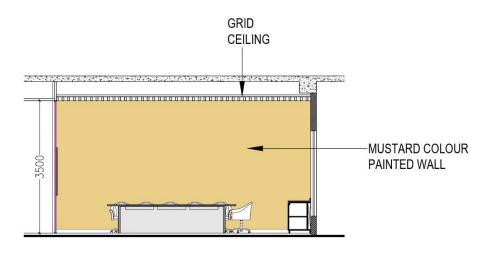
UNIVERSITY OF SRI JAYEWARDENEPURA, **SRI LANKA**

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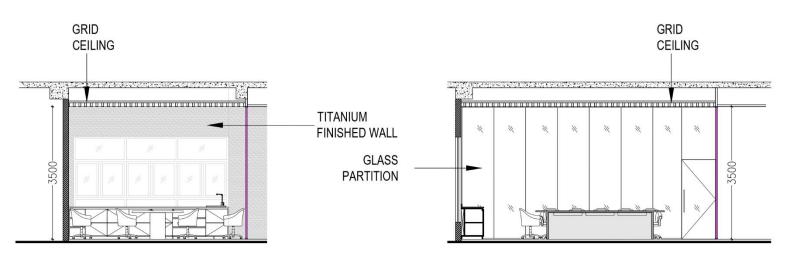
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SECTIONAL ELEVATION - A'



SECTIONAL ELEVATION - B'



800

SECTIONAL ELEVATION - C'

SECTIONAL ELEVATION - D'

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DRAWING TITLE

SECTIONAL ELEVATIONS - BLOCK A -MEETING ROOM

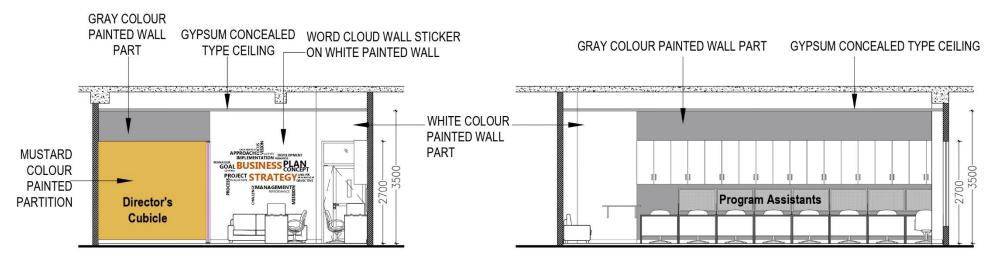
DRAWING NO DATE ISSUED JOB NO: 008 SCALE: 1:50 PREPARED BY: MW CHECKED BY: CU



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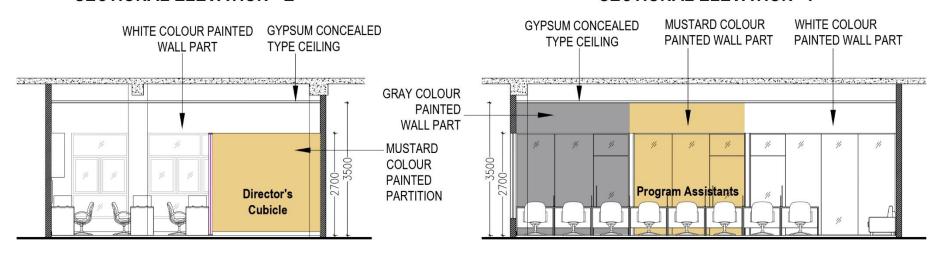
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SECTIONAL ELEVATION - E

SECTIONAL ELEVATION - F



SECTIONAL ELEVATION - G

SECTIONAL ELEVATION - H

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GENERAL NOTES VERIFY MEASUREMENTS ON SITE

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SECTIONAL ELEVATIONS - BLOCK B

009 JOB NO: 008 SCALE: 1:50 PREPARED BY: MW CHECKED BY: CU

DATE ISSUED

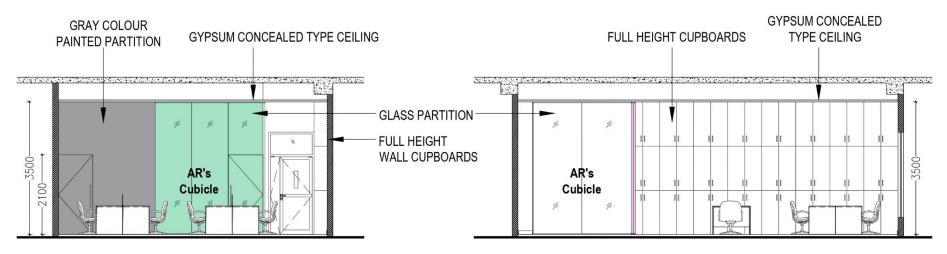
DRAWING NO



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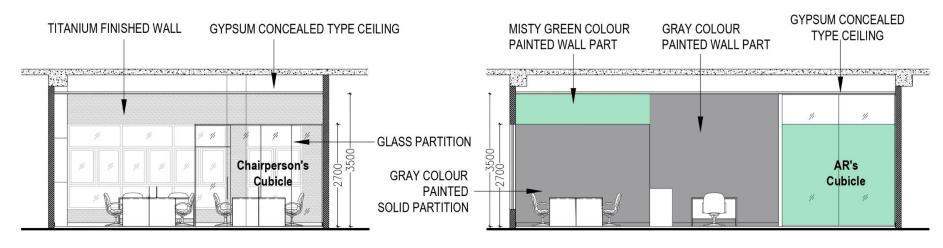
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SECTIONAL ELEVATION - J

SECTIONAL ELEVATION - K



SECTIONAL ELEVATION - L

SECTIONAL ELEVATION - M

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GENERAL NOTES

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PROJECT
PROPOSED INTERIOR FOR POSTGRADUATE CENTER FOR BUSINESS STUDIES

DRAWING TITLE
SECTIONAL ELEVATIONS - BLOCK C

CHECKED BY: CU

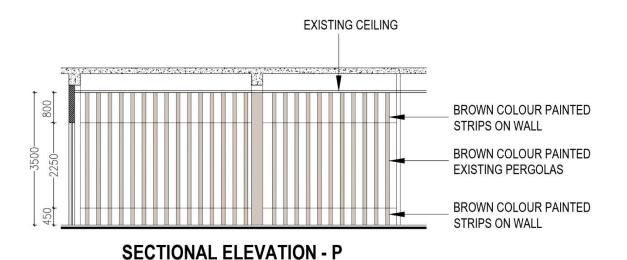
PREPARED BY: MW



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GENERAL NOTES

VERIFY MEASUREMENTS ON SITE BEFORE COMMENCING THE WORK

ROJECT

PROPOSED INTERIOR FOR POSTGRADUATE CENTER FOR BUSINESS STUDIES

DRAWING TITLE

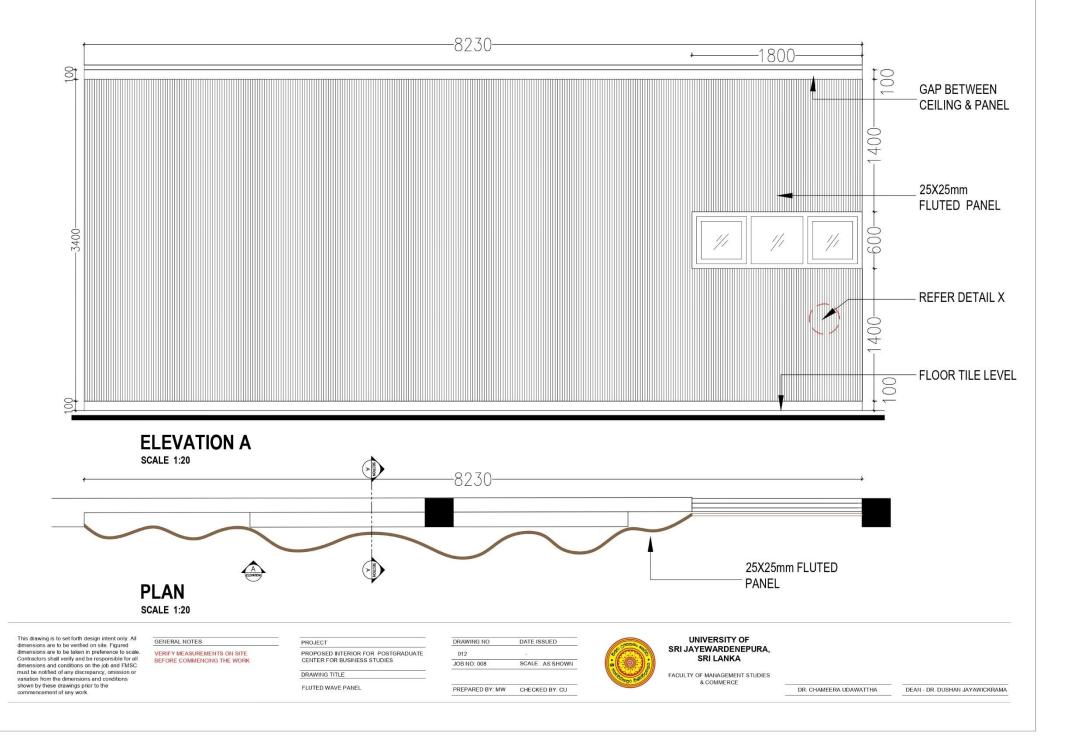
SECTIONAL ELEVATIONS - BLOCK D

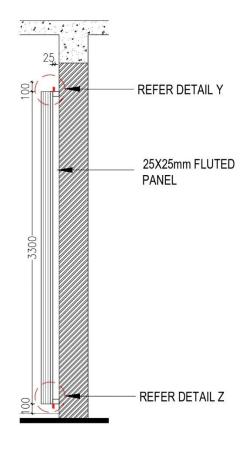


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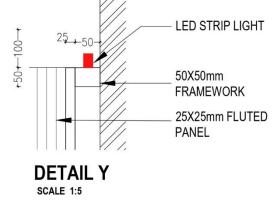
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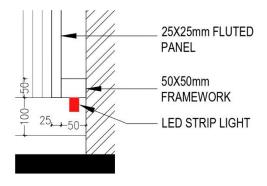
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DETAIL Z SCALE 1:5

SECTION A - A

SCALE 1:20

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GENERAL NOTES

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PROJEC

PROPOSED INTERIOR FOR POSTGRADUATE

DRAWING TITLE

FLUTED WAVE PANEL

 DRAWING NO
 DATE ISSUED

 013

 JOB NO: 008
 SCALE: AS SHOWN

PREPARED BY: MW CHECKED BY: CU



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DRAWING TITLE

3D IMAGES - BLOCK A

DRAWING NO	DATE ISSUED		
014			
JOB NO: 008	SCALE: NTS		
PREPARED BY: MW	CHECKED BY: CL		





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GENERAL NOTES

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PROJEC

PROPOSED INTERIOR FOR POSTGRADUATE CENTER FOR BUSINESS STUDIES

DRAWING TITLE

3D IMAGES - BLOCK B

DRAWING NO	DATE ISSUED	
015		
JOB NO: 008	SCALE: NTS	

PREPARED BY: MW CHECKED BY: CU



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GENERAL NOTES

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PROJECT

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DRAWING TITLE

3D IMAGES - BLOCK C

DRAWING NO	DATE ISSUED		
016	-		
JOB NO: 008	SCALE: NTS		
PREPARED BY: MW	CHECKED BY: CI		





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DRAWING TITLE

3D IMAGES - BLOCK C

DRAWING NO	DATE ISSUED		
017			
JOB NO: 008	SCALE: NTS		
PREPARED BY: MW	CHECKED BY: CL		



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GENERAL NOTES

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PROJECT

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DRAWING TITLE

3D IMAGES - BLOCK D

DRAWING NO	DATE ISSUED	
018		
JOB NO: 008	SCALE: NTS	

PREPARED BY: MW CHECKED BY: CU



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Section - 9

STANDARD FORMS (BID)

- Bid Security
- Bid Securing Declaration

Notes on Standard Forms

- Bidders shall submit the completed Form of Bid Security/Bid Security Declaration as appropriate in compliance with the requirements of the bidding documents.
- Bidders should not complete the Form of Agreement at the time of preparation of bids.
- The successful bidder will be required to sign the Form of Agreement, after the award of contract.
- Any corrections or modifications to the accepted bid resulting from arithmetic corrections, acceptable deviations, or quantity variations in accordance with the requirements of the bidding documents should be incorporated into the Agreement.
- The Form of Performance Security, Form of Advance Payment Security and Form of Retention Money Guarantee should not be completed by the bidder at the time of preparation of bids.
- The successful bidder will be required to provide the securities in compliance with the requirements herein or as acceptable to the Employer.

FORM OF BID SECURITY (UNCONDITIONAL ON DEMAND)

[this Guarantee form shall be filled in accordance with the instructions indicated in brackets]
issuing [insert
agency's name, and address of issuing branch or office]-
Beneficiary: Vice Chancellor, University of Sri Jayewardenepura, Gangodawila, Nugegoda.
Date: [insert (by issuing agency) date]
BID GUARANTEE No.: [insert (by issuing agency) number]
We have been informed that
Furthermore, we understand that, according to your conditions Bids must be supported by a Bid Guarantee.
At the request of the bidder, we
(a) has withdrawn its Bid during the period of bid validity specified; or
(b) does hot accept the correction of errors in accordance with the Instructions to Bidders (hereinafter "the ITB"); or
(c) having been notified of the acceptance of its Bid by the Employer during the period of bid validity, (i) fails or refuses to execute the Contract Form, if required, or (ii) fails or refuses to furnish the Performance Security, in accordance with the ITB.
This Guarantee shall expire: (a) if the bidder is the successful bidder, upon our receipt of copies of the Contract signed by the bidder and of the Performance Security issued to you by the bidder; or (b)if the bidder is not the successful bidder, upon the earlier of (i) the successful bidder furnishing the performance security, otherwise it will remain in force up to
Consequently, any demand for payment under this Guarantee must be received by us at the office on or before that date.
[signature(s) of authorized representative (s)]

²¹ Name of the Employer as given in Clause I of the Instructions to Bidders

²² Insert date in accordance with Sub-Clause 16 of Instructions to Bidders

FORM OF BID SECURING DECLARATION

[If required, the Bidder shall fill in this form in accordance with the instructions indicated in brackets; * delete as appropriate]
Name of contract [insert name by PE]
Contract Identification No:
Invitation for Bid No.: [insert number by PE]
To:
I/We*, the undersigned, declare that:
1. I/ that, according to instructions to bidders (hereinafter "the 1TB"), bids must be supported by a bid-securing declaration;
2. I/We* accept that we shall be suspended from being eligible for contract award in any contract where bids have being invited by any of the Procuring Entity as defined in the Procurement Guidelines published by National Procurement Agency of Sri Lanka, for the period of time of three years starting on the latest date set for closing of bids of this bid, if I/We:
(a) withdraw our Bid during the period of bid validity period specified; or
(b) do not accept the correction of errors in accordance with the Instructions to Bidder of the Bidding Documents;
(c) having been notified of the acceptance of our Bid by-you, during the period of bid validity, (i) fail or refuse to execute the Contract Form, if required, or (ii) fail or refuse to furnish the performance security, in accordance with the 1TB.
3. I/We* understand this, bid securing declaration shall expire if we are not the successful bidder, upon the earlier of (i) the successful bidder furnishing the performance security or (ii) twenty-eight days after the expiration of our bid.
Signed[insert signature(s) of authorized representative]
In the Capacity of
Name
Dated on [insert day] day of [insert month] [insert year

Check List for Bidders

Bidders are advised to fill the following table:

ITEM	ITB Clause	YES (tick)	REFERENCE
Form of Bid			
Addressed to the Employer?	18		
Completed?	18		
Signed?	18		
Bid Security Declaration Form (if required)			
Properly filled and signed	16		
Bid Security (if required)			
Addressed to the Vice Chancellor?	16		
Format as required?	16		
Issuing Agency as specified?	16		
Amount as requesting?	16		
Validity 28 days beyond the validity of Bid?	16		
Qualification Information			
All relevant information completed?	4		
Signed?	4		
Addendum			
Contents of the addendum (if any) taken in to account?	10		
BID package			
All the documents given in ITB Clause 12 enclosed in the original and copy?	12		
ITB Clause 19 followed before sealing the Bid Package?	19		